

W2: Huebner Creek – Eckhert to Bandera Solicitation Number: CO-00420 Job No.: 15-4513

ADDENDUM 3 April 27, 2021

To Respondent of Record:

This addendum, applicable to work referenced above, is an amendment to the price proposal, plans and specifications and as such will be a part of and included in the Contract Documents. Acknowledge receipt of this addendum by entering the Addendum number and issue date on the space provided in submitted copies of the price proposal.

RESPONSES TO QUESTIONS

Q1: I've been through the plans 3 times & I can't find (3) three of the (11) eleven 4' FRP sanitary

manholes (bid item # 26). I've got manholes A 1- $\stackrel{?}{A}$ 28 (28), B 1 - $\stackrel{?}{M}$ 1 (13) for a total of 41, but

the bid quantity is 44 for FRP manholes.

Response: The Price Proposal and Plans have been updated to revise the manhole quantities to clarify the location and use of doghouse manholes throughout the plan and profile sheets.

Sheet G5 has been updated with quantities for doghouse manholes by including a new line item for 852A Sanitary Sewer Doghouse Manhole. Sheet C17 included an additional manhole that was not required. Sheets C16, C18, and C31 have their quantity boxes revised to include 852A Sanitary Sewer Doghouse Manholes.

Price Proposal has been updated to include line item 26: 852A Sanitary Sewer Doghouse Manhole. Line Item 27: 852A Sanitary Sewer Manhole, 853A Fiber-Reinforced Sanitary Sewer Manhole – 4' Diameter Fiberglass Manhole, had its quantity reduced by moving the doghouse manholes to line item 26.

Refer to the "Changes to Specifications" item number 1 and "Changes to Plans" item number 1 within this Addendum.

CHANGES TO SPECIFICATIONS

1. Price Proposal, remove in its entirety and replace with the revised version attached to the Addendum. Respondents should use this version when submitting a proposal for this project. Failure to use this version could result in the Respondent's proposal being found non-responsive.

CHANGES TO PLANS

1. Remove sheets G5, C16, C17, C18, and C31 in their entirety and replace with sheet G5, C16, C17, C18, and C31 attached in this addendum.

END OF ADDENDUM 3

This Addendum is 15 pages in its entirety, including attachments.

Attachments:

- Price Proposal Form (8 pages)
- Plan Sheets G5, C16, C17, C18, and C31 (5 sheets)

V. Ryan Sowa, P.E.

Kimley-Horn and Associates, Inc.

 $W2: Huebner\,Creek\,-\,Eckhert\,to\,Bandera$

Solicitation No. CO-00420

PRICE PROPOSAL

PROPOSAL OF	, a corporation
a partnership consisting of	
an individual doing business as	
	itive Sealed Proposals, the undersigned proposes to furnish all labo equired for the project as specified, in accordance with the Plans and oposal to wit:
PLEASE SEE ATTACHED LIST OF BID ITI	EMS.
	RESPONDENT'S SIGNATURE & TITLE
	FIRM'S NAME (TYPE OR PRINT)
	FIRM'S ADDRESS
	FIRM'S PHONE NO. /FAX NO.
	FIRM'S EMAIL ADDRESS
The Contractor herein acknowledges receipt of the Addendum Nos	e following:
OWNER RESERVES THE RIGHT TO ACCEPT T	HE OVERALL MOST RESPONSIBLE PROPOSAL.
to complete the Project within <u>450</u> calendar days a	accordance with the Contract Documents for the contract price, and after the start date, as set forth in the Authorization to Proceed. The isions of the contract Documents relating to liquidated damages
Complete the additional requirements of the Propo	osal which are included on the following pages.
Statement on President's Executive Order	rs ·
Has your firm previously performed work su and 11375 or any preceding similar executive Yes \(\Boxed{\sqrt{No}}\) No \(\Boxed{\sqrt{\sqrt{No}}}\)	bject to the President's Executive Orders Numbers 11246 e orders (Numbers 10925 and 11114)?

LINE NO.	ITEM NO.	ITEM DESCRIPTION	QUANTITY	UNIT	UNIT PRICE	TOTAL PRICE
1	103.3	REMOVE SIDEWALKS AND DRIVEWAYS	1,700	SF	\$	\$
2	413.1	FLOWABLE FILL (LOW STRENGTH)	3,025	CY	\$	\$
3	503.2	PORTLAND CEMENT CONCRETE DRIVEWAY - COMMERCIAL	189	SY	\$	\$
4	505	CONCRETE RIPRAP (5" THICK)	122	SY	\$	\$
5	508.1	RELOCATING WIRE FENCE	60	LF	\$	\$
6	520.1	HYDROMULCHING (RESIDENTIAL OR COMMERCIAL)	89,648	SY	\$	\$
7	530.1	BARRICADES, SIGNS AND TRAFFIC HANDLING	1	LS	\$	\$
8	540	STORM WATER POLLUTION PREVENTION PLAN	1	LS	\$	\$
9	550.1	TRENCH EXCAVATION SAFETY PROTECTION	8,415	LF	\$	\$
10	848A	6-INCH SDR-26 (ASTM D- 3034) PVC SANITARY SEWER LINE (6' TO 10')	54	LF	\$	\$
11	848A	8-INCH SDR-26 (ASTM D- 3034) PVC SANITARY SEWER LINE (6' TO 10')	34	LF	\$	\$
12	848A	8-INCH SDR-26 (ASTM D- 3034) PVC SANITARY SEWER LINE (10' TO 14')	291	LF	\$	\$
13	848A	8-INCH SDR-26 (ASTM D- 3034) PVC SANITARY SEWER LINE (14' TO 18')	27	LF	\$	\$
14	848A	8-INCH SDR-26 (ASTM D- 3034) PVC SANITARY SEWER LINE (18' TO 22')	31	LF	\$	\$
15	848A	10-INCH SDR-26 (ASTM D- 3034) PVC SANITARY SEWER LINE (6' TO 10')	59	LF	\$	\$
16	848A	12-INCH SDR-26 (ASTM D- 3034) PVC SANITARY SEWER LINE (6' TO 10')	215	LF	\$	\$
17	848A	12-INCH SDR-26 (ASTM D- 3034) PVC SANITARY SEWER LINE (10' TO 14')	12	LF	\$	\$

18	848A	12-INCH SDR-26 (ASTM D- 3034) PVC SANITARY SEWER LINE (14' TO 18')	57	LF	\$ \$
19	848A	12-INCH SDR-26 (ASTM D- 3034) PVC SANITARY SEWER LINE (18' TO 22')	27	LF	\$ \$
20	848A	12-INCH SDR-26 (ASTM D- 3034) PVC SANITARY SEWER LINE (22' TO 25')	8	LF	\$ \$
21	848A	24-INCH SDR-26 (ASTM F- 679) PVC SANITARY SEWER LINE (6' TO 10')	91	LF	\$ \$
22	848A	24-INCH SDR-26 (ASTM F- 679) PVC SANITARY SEWER LINE (10' TO 14')	520	LF	\$ \$
23	848A	24-INCH SDR-26 (ASTM F- 679) PVC SANITARY SEWER LINE (14' TO 18')	1,903	LF	\$ \$
24	848A	24-INCH SDR-26 (ASTM F- 679) PVC SANITARY SEWER LINE (18' TO 22')	48	LF	\$ \$
25	848B	SANITARY SEWERS - PIPE TESTING AND ACCEPTANCE	3,377	LF	\$ \$
26	852A	SANITARY SEWER DOGHOUSE MANHOLE	3	EA	\$ \$
27	852A 853A	SANITARY SEWER MANHOLE FIBER-REINFORCED SANITARY SEWER MANHOLE - 4' DIAMETER FIBERGLASS MANHOLE	8	EA	\$ \$
28	852A 853A	SANITARY SEWER DROP MANHOLE FIBER-REINFORCED SANITARY SEWER MANHOLE - 4' DIAMETER FIBERGLASS MANHOLE W/ DROP	13	EA	\$ \$
29	852A 853A	EXTRA DEPTH MANHOLE (>6') FIBER-REINFORCED SANITARY SEWER MANHOLE - 4' DIAMETER FIBERGLASS MANHOLE, EXTRA DEPTH (>6')	45	VF	\$ \$

W2: Huebner Creek – Eckhert to Bandera

30	852A 853A	EXTRA DEPTH DROP MANHOLE (>6') FIBER-REINFORCED SANITARY SEWER MANHOLE - 4' DIAMETER FIBERGLASS MANHOLE W/ DROP, EXTRA DEPTH (>6')	119	VF	\$ \$
31	852B 853B	SANITARY SEWER MANHOLES - MANHOLE TESTING AND ACCEPTANCE FIBER-REINFORCED SANITARY SEWER MANHOLE - 4' DIAMETER FIBERGLASS MAHOLE TESTING AND ACCEPTANCE	21	EA	\$ \$
32	853A SP850	FIBER-REINFORCE SANITARY SEWER MANHOLE – 6' DIAMETER FIBERGLASS MANHOLE OR POLYMER CONCRETE SANITARY SEWER STRUCTURE - 6' DIAMETER	5	EA	\$ \$
33	853A	FIBER-REINFORCED SANITARY SEWER MANHOLE - 6' DIAMETER FIBERGLASS MANHOLE, EXTRA DEPTH (>6')	89	VF	\$ \$
34	853A SP850	SANITARY SEWER STRUCTURE - 6' DIAMETER	7	EA	\$ \$
35	853A	FIBER-REINFORCED SANITARY SEWER MANHOLE - TEE BASE FIBERGLASS MANHOLE, MITER, EXTRA DEPTH (>6')	107	VF	\$ \$

		FIBER-REINFORCED SANITARY SEWER MANHOLE - TEE BASE			
36	853A SP850	FIBERGLASS MANHOLE, MITER W/ DROP OR POLYMER CONCRETE SANITARY SEWER STRUCTURE - 6' DIAMETER	9	EA	\$ \$
37	853A	FIBER-REINFORCED SANITARY SEWER MANHOLE - TEE BASE FIBERGLASS MANHOLE, MITER W/ DROP, EXTRA DEPTH (>6')	138	VF	\$ \$
38	853B	FIBER-REINFORCED SANITARY SEWER MANHOLES - MANHOLE TESTING AND ACCEPTANCE	21	EA	\$ \$
39	857A	36-INCH FRP (ASTM D- 3262) (PS 72) SANITARY SEWER LINE (14' TO 18')	1,640	LF	\$ \$
40	857A	36-INCH FRP (ASTM D- 3262) (PS 72) SANITARY SEWER LINE (18' TO 22')	1,168	LF	\$ \$
41	857A	36-INCH FRP (ASTM D- 3262) (PS 72) SANITARY SEWER LINE (22' TO 25')	50	LF	\$ \$
42	857A	42-INCH FRP (ASTM D- 3262) (PS 72) SANITARY SEWER LINE (18' TO 22')	1,101	LF	\$ \$
43	857A	42-INCH FRP (ASTM D- 3262) (PS 72) SANITARY SEWER LINE (22' TO 25')	826	LF	\$ \$
44	857A	42-INCH FRP (ASTM D- 3262) (PS 72) SANITARY SEWER LINE (25' TO 30')	235	LF	\$ \$
45	857B	FIBERGLASS REINFORCED PIPE FOR LARGE DIAMETER GRAVITY SEWER: PIPE TESTING AND ACCEPTANCE	5,020	LF	\$ \$
46	02314 02341 02345	JACKING, BORING OR TUNNELING (24")	306	LF	\$ \$
47	02314 02341 02345	JACKING, BORING OR TUNNELING (54")	545	LF	\$ \$
48	02314 02341 02345	JACKING, BORING OR TUNNELING (60")	2,755	LF	\$ \$

W2: Huebner Creek – Eckhert to Bandera

		CARRIER PIPE FOR			
49	02349	JACKING, BORING OR TUNNELING (8" PVC SDR26 PVC GRAVITY SEWER CARRIER PIPE IN TUNNEL)	159	LF	\$ \$
50	02349	CARRIER PIPE FOR JACKING, BORING OR TUNNELING (12" PVC SDR26 PVC GRAVITY SEWER CARRIER PIPE) (OPEN CUT)	165	LF	\$ \$
51	02349	CARRIER PIPE FOR JACKING, BORING OR TUNNELING (36" PS 72 FRP GRAVITY SEWER CARRIER PIPE IN TUNNEL)	545	LF	\$ \$
52	02349	CARRIER PIPE FOR JACKING, BORING OR TUNNELING (42" FRP GRAVITY SEWER CARRIER PIPE IN TUNNEL)	2,755	LF	\$ \$
53	02610	STEEL CASING (.375" THICK) 24" (6", 8", 10", 12" PVC)	306	LF	\$ \$
54	02610	STEEL CASING (.375" THICK) 24" (6", 8", 10", 12" PVC) (OPEN CUT)	18	LF	\$ \$
55	02610	STEEL CASING (0.5" THICK) 54" OR LINER PLATE 56" (36"FRP)	545	LF	\$ \$
56	02610	STEEL CASING (0.5" THICK) 60" OR LINER PLATE 62" (42"FRP)	2,755	LF	\$ \$
57	858	CONCRETE ENCASEMENT, CRADLES, SADDLES, AND COLLARS	23	CY	\$ \$
58	862.2	ABANDONMENT OF SANITARY SEWER MAIN (6-INCH SANITARY SEWER LINE)	60	LF	\$ \$
59	862.2	ABANDONMENT OF SANITARY SEWER MAIN (8-INCH SANITARY SEWER LINE)	310	LF	\$ \$
60	862.2	ABANDONMENT OF SANITARY SEWER MAIN (10-INCH SANITARY SEWER LINE)	136	LF	\$ \$

W2: Huebner Creek – Eckhert to Bandera

61	862.2	ABANDONMENT OF SANITARY SEWER MAIN (21-INCH SANITARY SEWER LINE)	2,663	LF	\$ \$
62	862.2	ABANDONMENT OF SANITARY SEWER MAIN (24-INCH SANITARY SEWER LINE)	7,357	LF	\$ \$
63	864-S1	BYPASS PUMPING (SMALL DIAMETER SANITARY SEWERS)	1	LS	\$ \$
64	864-S2	BYPASS PUMPING (LARGE DIAMETER SANITARY SEWERS)	1	LS	\$ \$
65	866A	EXISTING SEWER MAIN PRE TELEVISION INSPECTION	15,135	LF	\$ \$
66	866	SEWER MAIN POST TELEVISION INSPECTION (8" THROUGH 15")	1,028	LF	\$ \$
67	866	SEWER MAIN POST TELEVISION INSPECTION (18" THROUGH 24")	2,561	LF	\$ \$
68	866	SEWER MAIN POST TELEVISION INSPECTION (30" OR GREATER)	8,320	LF	\$ \$
69	SP820 A	CSC PIPE JOINT INSPECTION	4	EA	\$ \$
70	SP820 B	CSC PIPE JOINT WELD	4	EA	\$ \$

SUBTOTAL (LINES 1 - 70) \$	
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W2: Huebner Creek - Eckhert to Bandera

Solicitation No. CO-00420

LINE NO.	ITEM NO.	ITEM DESCRIPTION	QUANTITY	UNIT	UNIT PRICE	TOTAL PRICE
71	100.1	MOBILIZATION (MAX 10% OF ITEMS 1 TO 70)	1	LS	\$	\$
72	100	INTERMEDIATE DEMOBILIZATION BYPASS EQUIPMENT RENTAL	20	MD	\$	\$
73	100	INTERMEDIATE DEMOBILIZATION BYPASS PUMPING FUEL	20	MD	\$	\$
74	100	INTERMEDIATE DEMOBILIZATION BYPASS WATCH	20	MD	\$	\$
75	SP100 INTERMEDIATE DEMOBILIZATION/REMOBI LIZATION (OPEN CUT)	$\begin{bmatrix} SP100 \\ A \end{bmatrix}$ DEMOBILIZATION/REMOBI 2	DEMOBILIZATION/REMOBI 2 E.	EA	\$	\$
76	SP100 B	INTERMEDIATE DEMOBILIZATION/REMOBI LIZATION (TRENCHLESS)	2	EA	\$	\$
77	101.1	PREPARATION OF RIGHT- OF-WAY (MAX 5% OF ITEMS 1 TO 70)	1	LS	\$	\$

*Note: "MD" stands for "Man Days"

SUBTOTAL (LINES 71 - 77)	\$
GODI GIAL (LINES / 1 - / /)	Ψ

Mobilization and Prep of ROW shall be limited to the maximum percentage shown. If the percentage exceeds the allowable maximum stated for mobilization and or preparation of ROW, SAWS reserves the right to cap the amount at the percentages shown and adjust the extensions of the bid items accordingly.

TOTAL BID PRICE	
(TO INCLUDE LINE ITEMS 1 - 70 AND 71-77)	\$

General Sanitary Sewer Quantities

ITEM NO.	DESCRIPTION	UNIT	QUANTITY
103.3	REMOVE SIDEWALKS AND DRIVEWAYS	SF	1,700
413.1	FLOWABLE FILL (LOW STRENGTH)	CY	3,025
503.2	PORTLAND CEMENT CONCRETE DRIVEWAY - COMMERCIAL	SY	189
505	CONCRETE RIPRAP (5" THICK)	SY	122
508.1	RELOCATING WIRE FENCE	LF	60
520.1	HYDROMULCHING (RESIDENTIAL OR COMMERCIAL)	SY	89,648
530.1	BARRICADES, SIGNS AND TRAFFIC HANDLING	LS	1
540	STORM WATER POLLUTION PREVENTION PLAN	LS	1
550.1	TRENCH EXCAVATION SAFETY PROTECTION	LF	8,415
848A	6-INCH SDR-26 (ASTM D-3034) PVC SANITARY SEWER LINE (6' TO 10')	LF	54
848A	8-INCH SDR-26 (ASTM D-3034) PVC SANITARY SEWER LINE (6' TO 10')	LF	34
848A	8-INCH SDR-26 (ASTM D-3034) PVC SANITARY SEWER LINE (10' TO 14')	LF	291
848A	B-INCH SDR-26 (ASTM D-3034) PVC SANITARY SEWER LINE (14' TO 18')	LF	27
848A	B-INCH SDR-26 (ASTM D-3034) PVC SANITARY SEWER LINE (18' TO 22')	LF	31
848A	10-INCH SDR-26 (ASTM D-3034) PVC SANITARY SEWER LINE (6' TO 10')	LF	59
848A	12-INCH SDR-26 (ASTM D-3034) PVC SANITARY SEWER LINE (6' TO 10')	LF	215
848A	12-INCH SDR-26 (ASTM D-3034) PVC SANITARY SEWER LINE (10' TO 14')	LF	12
848A	12-INCH SDR-26 (ASTM D-3034) PVC SANITARY SEWER LINE (14' TO 18')	LF	57
848A	12-INCH SDR-26 (ASTM D-3034) PVC SANITARY SEWER LINE (18' TO 22')	LF	27
848A	12-INCH SDR-26 (ASTM D-3034) PVC SANITARY SEWER LINE (18 TO 22)	IF.	8
848A	24-INCH SDR-26 (ASTM F-679) PVC SANITARY SEWER LINE (6" TO 10")	LF	91
848A	24-INCH SDR-26 (ASTM F-679) PVC SANITARY SEWER LINE (10 TO 14')	LF	520
848A	24-INCH SDR-26 (ASTM F-679) PVC SANITARY SEWER LINE (14" TO 18")	IF.	1,903
848A	24-INCH SDR-26 (ASTM F-679) PVC SANITARY SEWER LINE (18' TO 22')	LF	48
	Y Y	LF	3.377
848B 852A	SANITARY SEWERS - PIPE TESTING AND ACCEPTANCE SANITARY SEWER DOGHOUSE MANHOLE	FA	3377
852A	SANITARY SEWER MANHOLE SANITARY SEWER MANHOLE	+	
853A	FIBER REINFORCED SANTIARY SEWER MANHOLE - 4 DIAMETER FIBER GLASS MANHOLE SANTIARY SEWER DROP MANHOLE	EA COCOC	*
852A 853A		EA	13
852A 853A	FIBER-REINFORGED SANITARY SEWER MANHOLE - 4" DIAMETER FIBERGLASS MANHOLE W. DIKOP EXTRA DEPTH MANHOLE (-8) FIBER-REINFORGED SANITARY SEWER MANHOLE - 4" DIAMETER FIBERGLASS MANHOLE, EXTRA DEPTH (-6)	VF	45
852A 853A	EXTRA DEPTH DROP MANHOLE (>6') FIBER-REINFORCED SANITARY SEWER MANHOLE - 4' DIAMETER FIBERGLASS MANHOLE W/ DROP, EXTRA DEPTH (>6')	VF	119
852B 853B	SANITARY SEWER MANHOLES - MANHOLE TESTING AND ACCEPTANCE FIBER-REINFORCED SANITARY SEWER MANHOLE - 4" DIAMETER FIBERGLASS MAHOLE TESTING AND ACCEPTANCE	EA	21
853A SP850	FIBER-REINFORCE SANITARY SEWER MANHOLE - 6' DIAMETER FIBERGLASS MANHOLE OR POLYMER CONCRETE SANITARY SEWER STRUCTURE - 6' DIAMETER	EA	5
853A	FIBER-REINFORCED SANITARY SEWER MANHOLE - 6' DIAMETER FIBERGLASS MANHOLE, EXTRA DEPTH (>6')	VF VF	89
853A	FIBER-REINFÖRGED SANITARY SEWER MANHOLE - TEE BASE FIBERGLASS MANHOLE. MITER OR	 	
SP850	POLYMER CONCRETE SANITARY SEWER STRUCTURE - 6' DIAMETER	EA	7
853A	TIBER-REINFÖRGED SANITARY SEWER MANHOLE - TEE BASE FIBERGLASS MANHOLE, MITER EXTRA DEPTH 15-67	VF	
853A SP850	FIBER-REINFORCED SANITARY SEWER MANHOLE - TEE BASE FIBERGLASS MANHOLE, MITER W/ DROP OR POLYMER CONCRETE SANITARY SEWER STRUCTURE - 6' DIAMETER	EA	9
853A	FIBER-REINFORCED SANITARY SEWER MANHOLE - TEE BASE FIBERGLASS MANHOLE, MITER W/ DROP, EXTRA DEPTH (56)	VF	138
853B	FIBER-REINFORCED SANITARY SEWER MANHOLES - MANHOLE TESTING AND ACCEPTANCE	EA	21
857A	36-INCH FRP (ASTM D-3262) (PS 72) SANITARY SEWER LINE (14' TO 18')	LF	1,640
857A	36-INCH FRP (ASTM D-3262) (PS 72) SANITARY SEWER LINE (18' TO 22')	LF	1,168
857A	36-INCH FRP (ASTM D-3262) (PS 72) SANITARY SEWER LINE (22' TO 25')	LF	50
857A	42-INCH FRP (ASTM D-3262) (PS 72) SANITARY SEWER LINE (18' TO 22')	LF	1,101
857A	42-INCH FRP (ASTM D-3262) (PS 72) SANITARY SEWER LINE (22' TO 25')	LF	826
857A	42-INCH FRP (ASTM D-3262) (PS 72) SANITARY SEWER LINE (25 TO 30')	LF	235
857B	FIBERGLASS REINFORCED PIPE FOR LARGE DIAMETER GRAVITY SEWER: PIPE TESTING AND ACCEPTANCE	LF	5.020

ITEM N	TOTAL ESTIMATED QUANTITIES DESCRIPTION	UNIT	QUANTITY
02314	DESCRIPTION	UNIT	QUANTITY
0234 0234 0234	JACKING, BORING OR TUNNELING (24')	LF	306
02314 0234 02345	JACKING, BORING OR TUNNELING (54*)	LF	545
02314 0234 0234	JACKING, BORING OR TUNNELING (60")	LF	2755
02349	CARRIER PIPE FOR JACKING, BORING OR TUNNELING (8° PVC SDR26 PVC GRAVITY SEWER CARRIER PIPE IN TUNNEL)	LF	159
02349	CARRIER PIPE FOR JACKING, BORING OR TUNNELING (12" PVC SDR26 PVC GRAVITY SEWER CARRIER PIPE) (OPEN CUT)	LF	165
02349	CARRIER PIPE FOR JACKING, BORING OR TUNNELING (36° PS 72 FRP GRAVITY SEWER CARRIER PIPE IN TUNNEL)	LF	545
02349	CARRIER PIPE FOR JACKING, BORING OR TUNNELING (42° FRP GRAVITY SEWER CARRIER PIPE IN TUNNEL)	LF	2755
02610	SŤEEĽ CÁSING (375' THICK) 24' (6', 8', 10', 12' PVC)	LF	306
02610	STEEL CASING (.375" THICK) 24" (6", 8", 10", 12" PVC) (OPEN CUT)	LF	18
02610	STEEL CASING (0.5" THICK) 54" OR LINER PLATE 56" (36"FRP)	LF	545
02610	STEEL CASING (0.5" THICK) 60" OR LINER PLATE 62" (42"FRP)	LF	2755
858	CONCRETE ENCASEMENT, CRADLES, SADDLES, AND COLLARS	CY	23
862.2	ABANDONMENT OF SANITARY SEWER MAIN (6-INCH SANITARY SEWER LINE)	LF	60
862.2	ABANDONMENT OF SANITARY SEWER MAIN (8-INCH SANITARY SEWER LINE)	LF	310
862.2	ABANDONMENT OF SANITARY SEWER MAIN (10-INCH SANITARY SEWER LINE)	LF	136
862.2	ABANDONMENT OF SANITARY SEWER MAIN (21-INCH SANITARY SEWER LINE)	LF	2663
862.2	ABANDONMENT OF SANITARY SEWER MAIN (24-INCH SANITARY SEWER LINE)	LF	7357
864-S	BYPASS PUMPING (SMALL DIAMETER SANITARY SEWERS)	LS	1
864-S	BYPASS PUMPING (LARGE DIAMETER SANITARY SEWERS)	LS	202
866A	EXISTING SEWER MAIN PRE TELEVISION INSPECTION	LF	15135
866	SEWER MAIN POST TELEVISION INSPECTION (8" THROUGH 15")	LF	1028
866	SEWER MAIN POST TELEVISION INSPECTION (18" THROUGH 24")	LF	2561
866	SEWER MAIN POST TELEVISION INSPECTION (30° OR GREATER)	LF	8320
SP820	CSC PIPE JOINT INSPECTION	EA	4
SP820	CSC PIPE JOINT WELD	EA	4
100.1	MOBILIZATION (MAX 10% OF ITEMS 1 TO 69)	LS	1
100	INTERMEDIATE DEMOBILIZATION BYPASS EQUIPMENT RENTAL	MD	20
100	INTERMEDIATE DEMOBILIZATION BYPASS PUMPING FUEL	MD	20
100	INTERMEDIATE DEMOBILIZATION BYPASS WATCH	MD	20
SP100	INTERMEDIATE DEMOBILIZATION/REMOBILIZATION (OPEN CUT)	EA	2
SP100	INTERMEDIATE DEMOBILIZATION/REMOBILIZATION (TRENCHLESS)	EA	2
101.1	PREPARATION OF RIGHT-OF-WAY (MAX 5% OF ITEMS 1 TO 69)	LS	1



Kimley» Horn Texas Registered Firm, No. 928

Texas Registered Firm, No 601 NW Loop 410 Suite 35 San Antonio TX 78216

Fax No. 210-541-8699

No.	Revision	Вy	Date
Λ	ADDENDUM #1	VRS	03/12/2021
A	ADDENDUM #3	VRS	04/27/202





W2 HUEBNER CREEK: ECKHERT TO BANDERA

SHEET

OVERALL QUANTITIES

DATE: MARCH 2021	SAWS PROJECT NO.	SHEET NO.
DESIGN: VRS	15-4513	٥.
DRAWN: RKC	KHA PROJECT NO.	G5
CHECKED: JAF	068665009	

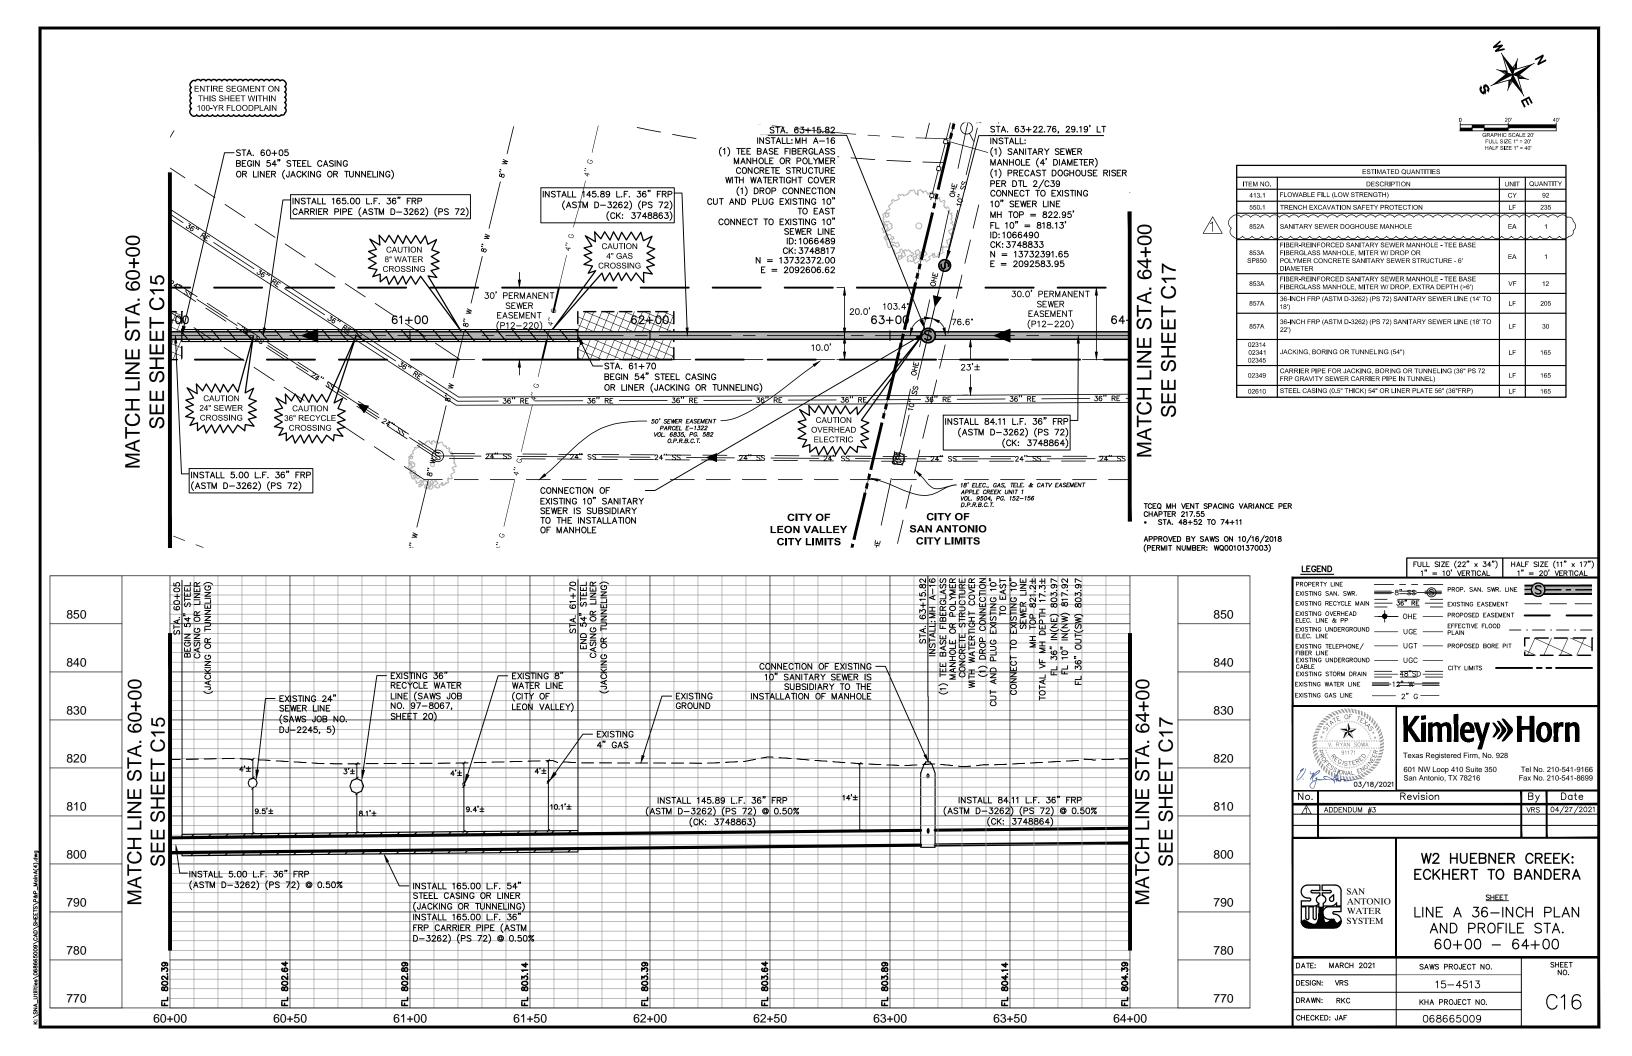

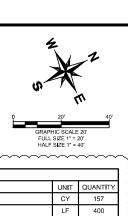


13


304

96

ESTIMATED QUANTITIES

DESCRIPTION

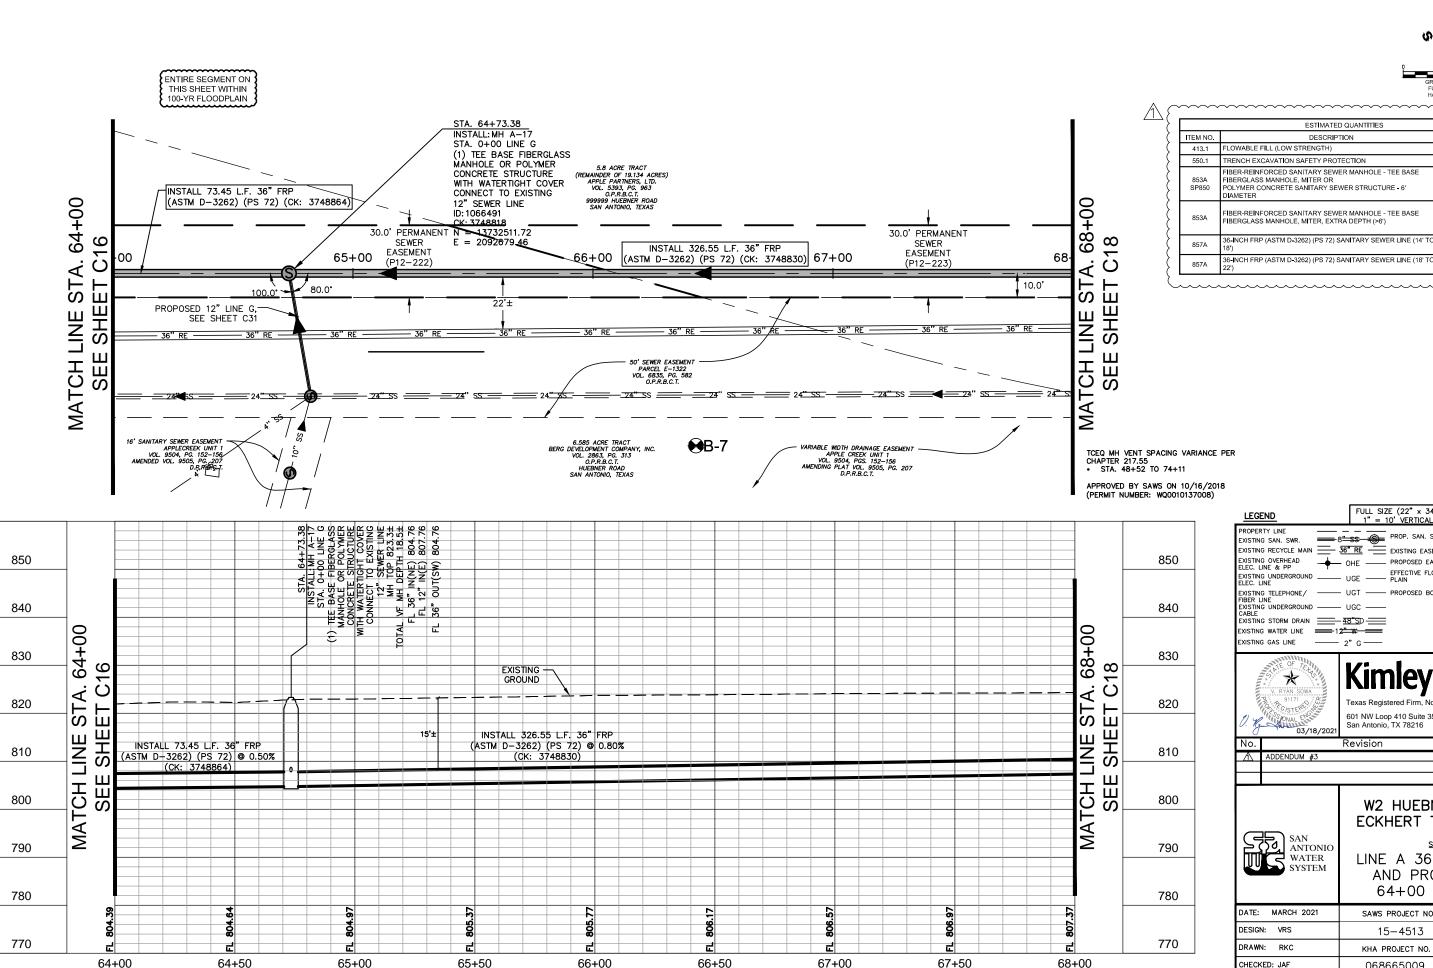

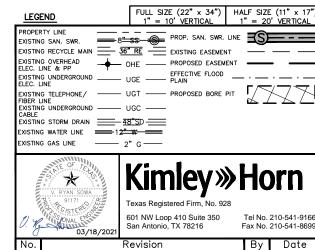





W2 HUEBNER CREEK: ECKHERT TO BANDERA


VRS 04/27/202


LINE A 36-INCH PLAN AND PROFILE STA. 64+00 - 68+00

DATE: MARCH 2021	SAWS PROJECT NO.	SHEET NO.
DESIGN: VRS	15-4513	
DRAWN: RKC	KHA PROJECT NO.	C17
CHECKED: JAF	068665009	

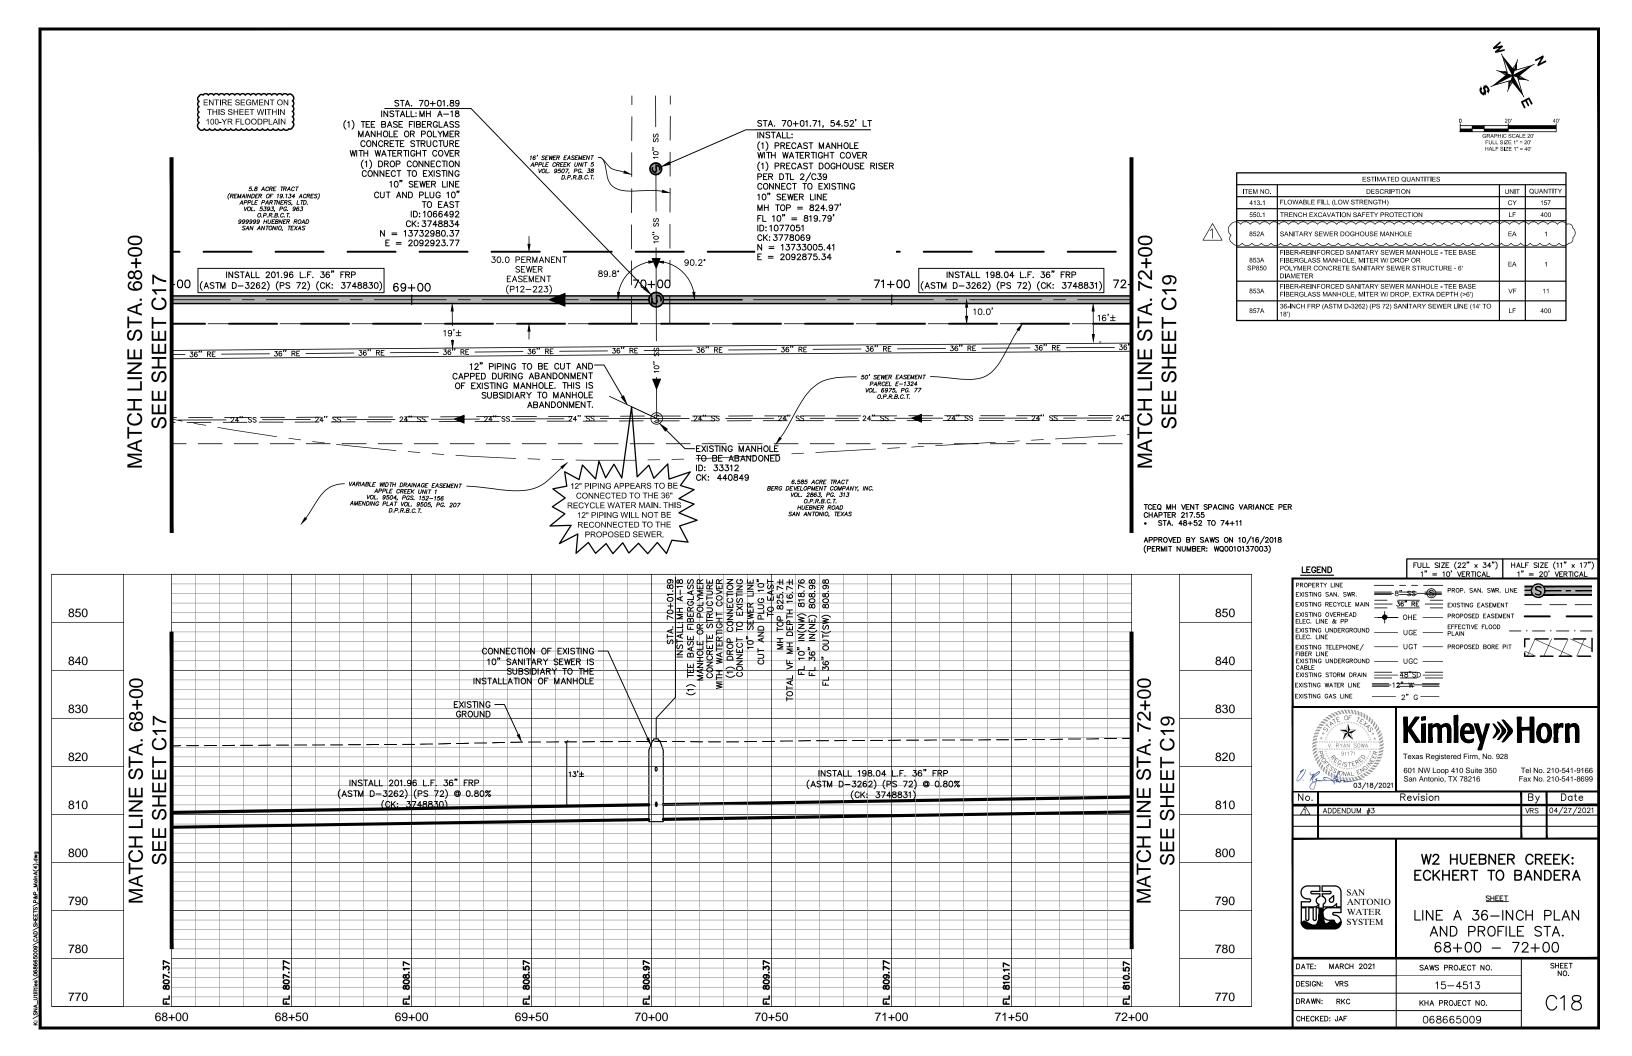

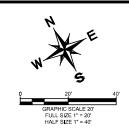

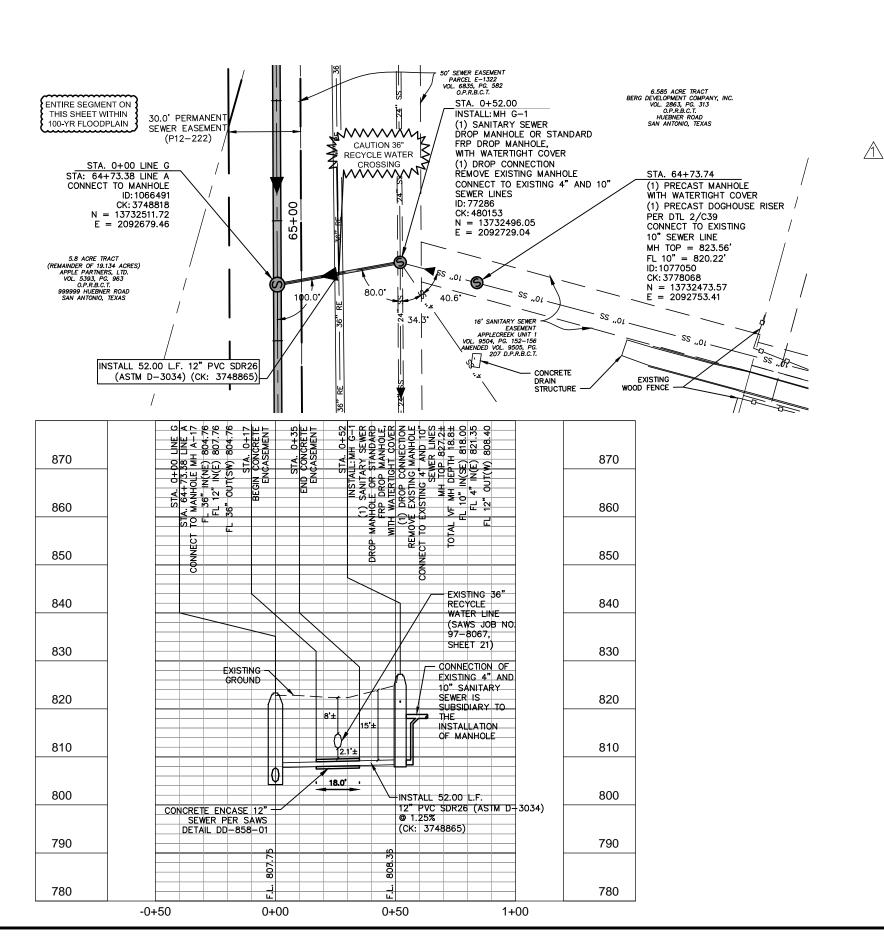

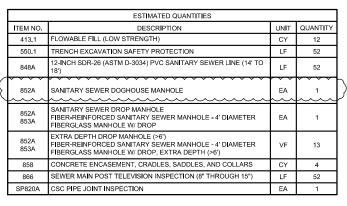

GENERAL NOTES:

1. CONTRACTOR TO SUBMIT SHOP DRAWINGS DETAILING BEDDING PROTECTION AND BRACING OF EXISTING UTILITIES BEING CROSSED OR ENCROACHING NEAR THE PROPOSED SEWER MAIN FOR REVIEW AND APPROVAL BY SAWS AND THE ENGINEER. THIS INCLUDES BUT IS NOT LIMITED TO ALL 21-INCH AND 24-INCH CLAY, CONCRETE, PVC SEWER MAINS, AID AS INCH RECYCLE WATER MAINS, AND 24-INCH CONCRETE WATER MAINS, THIS WORK IS SUBSIDIARY TO THE SEWER PIPE INSTALLATION PAY ITEM.

FULL SIZE (22" x 34") HALF SIZE (11" x 17" 1" = 10' VERTICAL 1" = 20' VERTICAL LEGEND PROPERTY LINE PROP. SAN. SWR. LINE EXISTING SAN. SWR. EXISTING RECYCLE MAIN ______ 36" RE _____ EXISTING EASEMENT OHE PROPOSED EASEMENT EXISTING OVERHEAD FLEC. LINE & PP UGE — EFFECTIVE FLOOD EXISTING TELEPHONE/ FIBER LINE ----- UGT ----- PROPOSED BORE PIT EXISTING UNDERGROUND — UGC — EXISTING WATER LINE = 12" W XISTING GAS LINE



601 NW Loop 410 Suite 350 San Antonio, TX 78216 Tel No. 210-541-9166 Fax No. 210-541-8699

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Λ	ADDENDUM #3	VRS	04/27/2021



W2 HUEBNER CREEK: ECKHERT TO BANDERA

SHEET

LINE G 12-INCH PLAN AND PROFILE STA. 0+00 - END

DATE: MARCH 2021	SAWS PROJECT NO.	SHEET NO.
DESIGN: VRS	15-4513	
DRAWN: RKC	KHA PROJECT NO.	C31
CHECKED: JAF	068665009	